

## CONSTRUCTION SEQUENCE

1. Start and Completion Dates: Start Date: Spring 2021 Completion Date: Spring 2022

2. Construction Sequence

 Obtain all permits Notify "Call Before You Dig" for utility marking.

- Notify all applicable town officials of start date and obtain a "Start Card"

from Litchfield Conservation Commission. - Install sediment fence at the toe of all proposed fill slopes and as shown on the

- Remove and stockpile topsoil. Stockpile to be seeded with annual rye grass

and mulched. Install anti-tracking pad at driveway entrance.

- Install house foundation and driveway.

- Grade subgrade to provide adequate surface drainage. Place topsoil on all disturbed areas.

Topsoil to be fertilized, seeded and mulched immediately.
Remove sedimentation controls when vegetation is established.
Obtain a "Stop Card" form the Litchfield Conservation Commission.

**GENERAL NOTES:** 

Owner of Record:

Noel Fisher 61 Tallmagde Lane Litchfield, CT 06759

Applicant:

61 Tallmagde Lane Litchfield, CT 06759

Zoning district: HR-30 (Historic Residences)

- Parcel Area: 0.46+/- acres Boundary and wetland location based on map entitled "Zoning Location Survey prepared for Noel Fisher T., 61 Tallmadge Lane Litchfield Connecticut" prepared by Roy V. Cheney, L.S. dated

Noel Fisher

Topographic information based on field survey by Roy V. Cheney, LS.
All construction to conform to town and State of Connecticut

specifications. - All utilities to be installed underground.

Existing building is connected to municipal water and sewer.
Property is located in the 6705 Subregional Drainage Basin.


FILTER FABRIC **BACKFILL** -SEPARATE SECTIONS OF FENCE TO BE WRAPPED AROUND BOTH END POLES TO MAKE A CONTINUOUS -HAYBALES MAY BE SUBSTITUTED OR USED WITH SEDIMENT FENCE AS DIRECTED BY TOWN OR ENGINEER. SEDIMENT FENCE DETAIL

## EROSION AND SEDIMENTATION CONTROL NOTES:

- EROSION AND SEDIMENTATION CONTROL MEASURES TO BE INSTALLED AT THE TOE OF SLOPES OR AS SHOWN ON THE PLANS.
- ALL MEASURES TO BE INSTALLED PRIOR TO GROUND DISTURBANCE. - TOPSOIL TO BE STRIPPED, STOCKPILED AND SEEDED IN ALL AREAS OF
- PROPOSED GRADING. - EROSION CONTROL MEASURES TO BE MAINTAINED THROUGHOUT THE CONSTRUCTION PROCESS UNTIL DISTURBED AREAS ARE STABILIZED.
- ADDITIONAL CONTROL MEASURES MAY BE NECESSARY.

   THE OWNER OF RECORD / CONTRACTOR SHALL BE RESPONSIBLE FOR THE
- INSTALLATION AND MAINTENANCE OF EROSION CONTROLS. - ALL EROSION AND SEDIMENTATION CONTROLS TO BE INSTALLED IN ACCORDANCE WITH THE 2002 CT GUIDELINES FOR SOIL EROSION
- AND SEDIMENT CONTROL.

LEGEND PROPERTY LINE BLDG. SETBACK LINE EASEMENT LINE \_\_\_\_\_ UTILITY POLE STONE WALL WATERCOURSE FLAGGED WETLANDS \_\_\_\_ EXISTING CONTOUR PROPOSED CONTOUR EXISTING SPOT ELEVATION 991.5 PROPOSED SPOT ELEVATION 991+5  $\bigcirc \bigcirc \bigcirc \bigcirc$ TREE LINE HAYBALE CHECK DAM SEDIMENT FENCE 

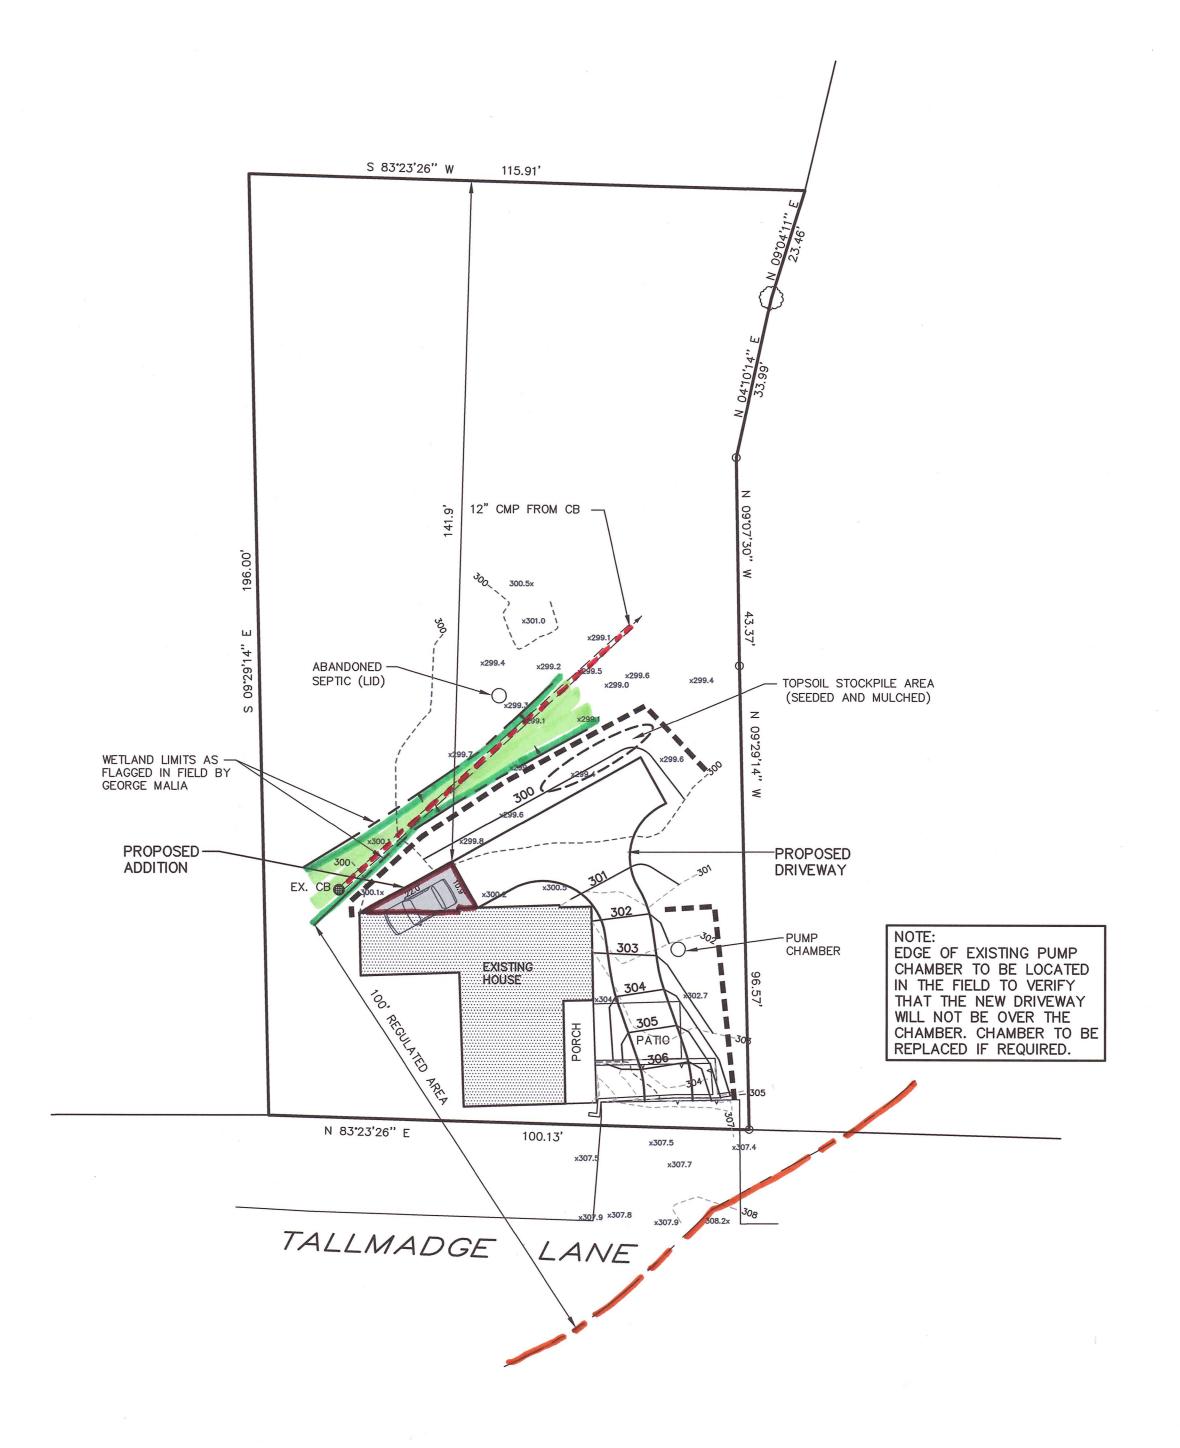

SITE PLAN PREPARED FOR NOEL FISHER 61 TALLMADGE LANE LITCHFIELD, CONNECTICUT

BERKSHIRE (

**ENGINEERING &** SURVEYING, LLC

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Date: 03/03/21 Proj. No.: **20-3396(SP)** Sheet: 1/1 Scale: 1"=20' Drawn By: MS/DSM Map No.: **3396**